Planned Outage and Interruption Request

Work Owner _____ Organization _____ Phone _____

Onsite Contact	:	Phone						
Project #		Customer Request WO Number						
Select Interruption Type:								
		Building Access Control		Elevator		Laboratory Utility		Sanitary Sewer
Building System Outage or Space Closure		Electric Power		Heating Ventilation & A/C (HVAC)		Natural Gas		Domestic Water
(Only if part of a building is out, Check all that apply)		Building Space/Entrances/ Occupant Flow		Telephone/IT		Fumehood		Cooler/Freezer
out, eneck an enacuppry)		Emergency Power (Life Safety Approval required)		Other (Explain below)				
Utility Outage		Electric Power		Natural Gas		Sewer from Building		Domestic Water
(If entire building is out)		Hot Water (Central Plant)		Chilled Water (Central Plant)		Steam (Central Plant)		Other (Explain Below)
		Roadway		Sidewalk		Bike Lane		Waste Receptacle
Outside Closures		Parking Spaces		ADA Facilities		Traffic Signal		Other (Explain below)
Life Safety System Outage (Required any time system		Fire Alarm		Fire Suppression System and/or Fire Pump		Special Hazards Range Hood		Fire Hydrant
or components are taken out of service)		Fire watch required? Yes or (Determined by Risk Management & S Engineer)						
Life Safety Notifications		Annual Fire Alarm Test and Inspection		Fire Suppression System Testing		Fire Alarm System Testing		Fire Alarm System Download
Notifications		Unplanned Outage		Preventative Maintenance		Risk Mgt. & Safety Inspection		Other (Explain below)
Description of Work Activity								
Building(s) or Location(s) Affected								
pecific Space Affected (Room Numbers)								
low are the building clients or University stakeholders affected? What will they notice?								
chedule: tart Date:Start Time:End Date:End Time:								

Page 1 of 3 R7 7/31/2021

Planned Outage and Interruption Request

Planning Reviews (Per Review Matrix):

Organization	Review Required?	Reviewer	Review Date
Maintenance Zone Manager or Supervisor			
Utility Supervisor			
Others as Needed			

Client Approvals (Per Approval Matrix):

Organizations Affected by Work, Interruption, or Outage							
Client	Building(s)	Key Contact	Approval Date				

Facilities Management Approvals (Per the Approval Matrix)

			ı	acilitie	es Managem	ent				
Maintenance			Utility and Energy				Design & Construction			
Approval Required?	Approved By:	Date	Approval Approved By: Date Required?		: Date	Approval Required?	Approved By:	Date		
	Bruce Arnol	d								
Campus	Services/Land	dscape								
Approval Required?	Approved By:	Date								
	For Life Safety Systems									
University Engineer			Risk Management and Safety							
Approval Required?	Approved By:	Date	Approval Required?	Approved		: Date				
	Bob Hix				Jessica Covingto	n and				
				Work	Managemer	nt				
Received By: Date		Received	ceived Time Received		Date N	otice Issued	Time Issued			
							·			

Work Owner Signature: <u>Kelly</u>	O'Neal-you	dugDate	
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Page 2 of 3 R7 7/31/2021

KEY PLAN- 3RD FLOOR

NOTE: NO DEMO DEBRIS TO GO THROUGH INTERIOR OF BUILDING. USE STAIR #2 ONLY FOR ACCESS AND DEBRIS REMOVAL NOTE: CONSTRUCTION ACCESS WILL BE THROUGH EAST FIRE STAIR. LIMITED ACCESS THROUGH LOBBY. MILLWORK TO BE REMOVED— NOTE: NOISY/DISRUPTIVE DEMO ZEXIST FLOOR TO TAKE PLACE OUTSIDE OF NORMAL CLASS HOURS FINISH & WALL BASE TO BE (8:00-5:00) FROM APRIL REMOVED — |21ST THROUGH MAY 9TH 2025| NOTE: GC MUST MEET WITH ZEXIST LIGHTING, AU BUILDING SCIENCES (BSCI) ACOUSTICAL CEILING GRID, REPRESENTATIVES AT THE EXIST LIGHTING,
ACOUSTICAL
CEILING GRID,
AND TILES TO
BE REMOVED BEGINNING OF EACH WEEK TO AND TILES TO BE REMOVED 7 REVIEW AND COORDINATE PRESERVE & CONSTRUCTION ACTIVITIES. PROTECT EXIST. MEETINGS SHALL BE HELD EXPOSED STEEL EACH MONDAY MORNING STRUCTURE WITH SHELVING TO BE REMOVED UNLESS OTHERWISE AGREED NOTE: ALL EQUIPMENT PREVIOUS CLASS'
SIGNATURES TYP. & SUPPLIES TO BE UPON WITH ALL REMOVED FROM SPACES PRIOR TO THE START STAKEHOLDERS l IT PERIPH. I Work OF CONSTRUCTION THESIS //wall to be REMOVED, ZEXIST FLOOR FINISH & WALL BASE TO BE REMOVED 7 MILLWORK TO BE REMOVED — MILLWORK TO BE -REMOVED EXIST. DOORS, FRAMES, & HARDWARE
TO BE REMOVED. AU ACCESS
CONTROL TO REMOVE CORE PRIOR
TO DOOR REMOVAL. GC TO TURN
OVER EXISTING HARDWARE TO OWNER. EXIST. FEC EXIST. DOOR TO BE REMOVED, EXIST. FRAME TO REMAIN. NEW HARDWARE TO TO REMAIN—— **STAIR #2**313
S302 BE PROVIDED WITH NEW DOOR — TURN OVER EXISTING HARDWARE TO OWNER.— CORRIDOR
302
C301 **VESTIBULE**[317]
C304 VESTIBULE
314
C303 VESTIBULE

O1 DEMO PLAN - THESIS LAB

1/4" = 1'-0"

Facilities Management

Facilities Management
1161 West Samford Avenue
Auburn University, AL 36849
Phone: (334) 844-4810
Fax: (334) 844-9458
Safety is our first priority.
Think Safety. Act Safely.

No. Revision Date

OF ALTONOMICS OF

ISSUED FOR: FINAL RESUBMITTA

ARCHITECTS

1800 International Park Drive
Suite 300
Birmingham, Alabama 35243
205/969-2696
www.cmharch.com
© 2024 CMH Architects, Inc.

M. Miller Gorrie Center hesis Studio - Room 325 & 32 Project Number 23-103

SHEET TITLE:

DEMO PLAN

DRAWN BY:
KLB


CHECKED BY:
BN

DATE:
12/20/2024

PROJECT NUMBER AU:
23-103
PROJECT NUMBER DCM:
20240699

PROJECT NUMBER CMH: 1912
SHEET NUMBER:

A1.0

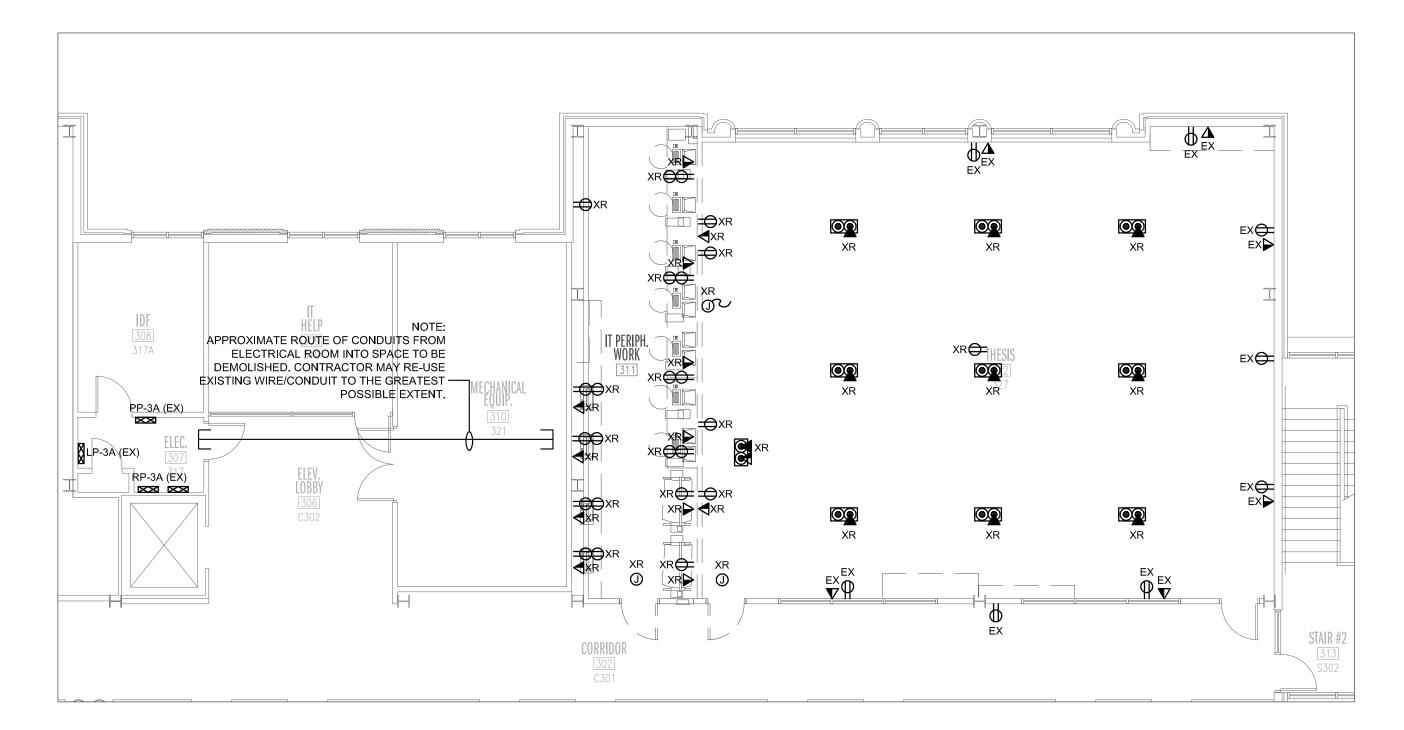




NOTES:

- APPROXIMATE LOCATION AND QUANTITY OF EXISTING LIGHTS SHOWN FOR REFERENCE. PROVIDE COMPLETE ELECTRICAL DEMOLITION OF EXISTING LIGHTS IN SCOPE OF WORK BACK TO PANEL AND/OR NEXT ACTIVE DEVICE. LIGHTS CIRCUITED THROUGH EXISTING RELAY PANEL. REMOVE ALL WIRING, CONDUIT, BOXES, SWITCHES, SENSORS, AND FIXTURES AS REQUIRED.
- DESIGN INTENT IS FOR ALL LIGHTS OUTSIDE SCOPE OF WORK TO REMAIN OPERATIONAL DURING CONSTRUCTION. CONTRACTOR TO TRACE AND IDENTIFY ALL IMPACTED CIRCUITS AND PERFORM ALL NECESSARY WORK TO ENSURE ANY LIGHTS OUTSIDE SCOPE OF WORK REMAIN OPERATIONAL.



NOTES:

- APPROXIMATE LOCATION AND QUANTITY OF EXISTING ELECTRICAL DEVICES SHOWN. PROVIDE COMPLETE DEMOLITION OF ALL DEVICES MARKED "XR." DEMOLITION TO INCLUDE WIRE, CONDUIT, BOXES, DEVICES, ETC. DO NOT ABANDON CONDUIT.
- DEVICES TO REMAIN MARKED "EX." PROTECT DURING CONSTRUCTION. PROVIDE NEW COVERPLATE TO MATCH NEW DEVICES.
- DEMOLISH FLOOR BOXES. COORDINATE DEMOLITION WITH OWNER. DEMOLITION WILL INVOLVE ACCESSING SPACE BELOW. SALVAGE AND TURN OVER TO OWNER.
- DESIGN INTENT IS FOR ALL DEVICES OUTSIDE SCOPE OF WORK TO REMAIN OPERATIONAL DURING CONSTRUCTION. CONTRACTOR TO TRACE AND IDENTIFY ALL IMPACTED CIRCUITS AND PERFORM ALL NECESSARY WORK TO ENSURE ANY DEVICES OUTSIDE SCOPE OF WORK REMAIN OPERATIONAL.

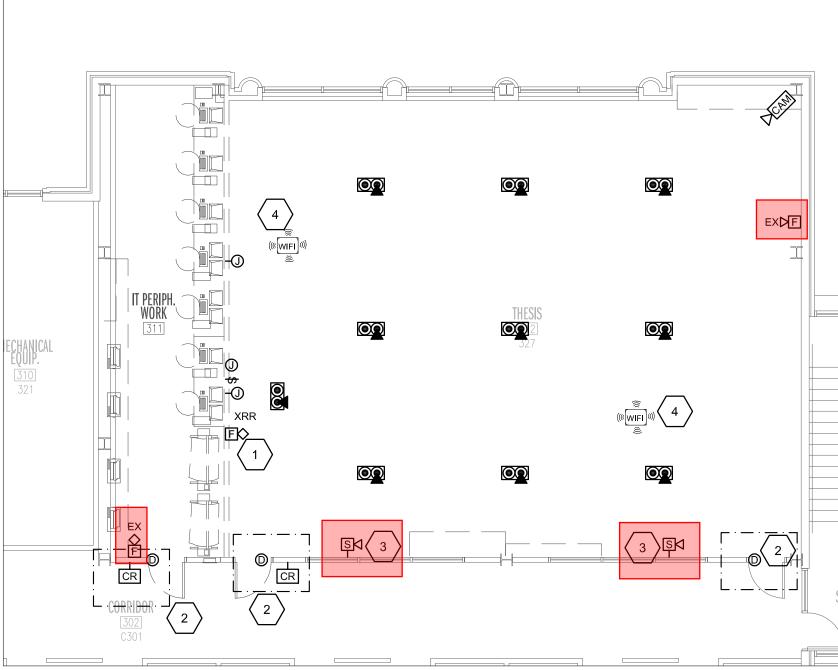


NOTES:

APPROXIMATE LOCATION AND QUANTITY OF EXISTING DEVICES SHOWN FOR REFERENCE. PROVIDE COMPLETE DEMOLITION OF ALL SYSTEMS SHOWN.

DEMOLITION KEYNOTES, AUXILIARY SYSTEMS:

- REMOVE EXISTING FIRE ALARM DEVICES PRIOR TO START OF DEMOLITION. DEVICES TO BE RELOCATED.
- EXISTING ACCESS CONTROLS TO BE DEMOLISHED. COORDINATE REMOVAL WITH OWNER SECURITY. REMOVE WIRE AND CONDUIT BACK TO SECURITY INTERFACE
- EXISTING SPEAKERS TO REMAIN.
- EXISTING CEILING MOUNTED WIRELESS ACCESS POINTS TO REMOVE. COORDINATE REMOVAL OF EQUIPMENT WITH AUBURN OIT PRIOR TO DEMOLITION. UPON COMPLETION OF WORK, COORDINATE RE-INSTALLATION OF WIRELESS ACCESS POINTS WITH AUBURN.

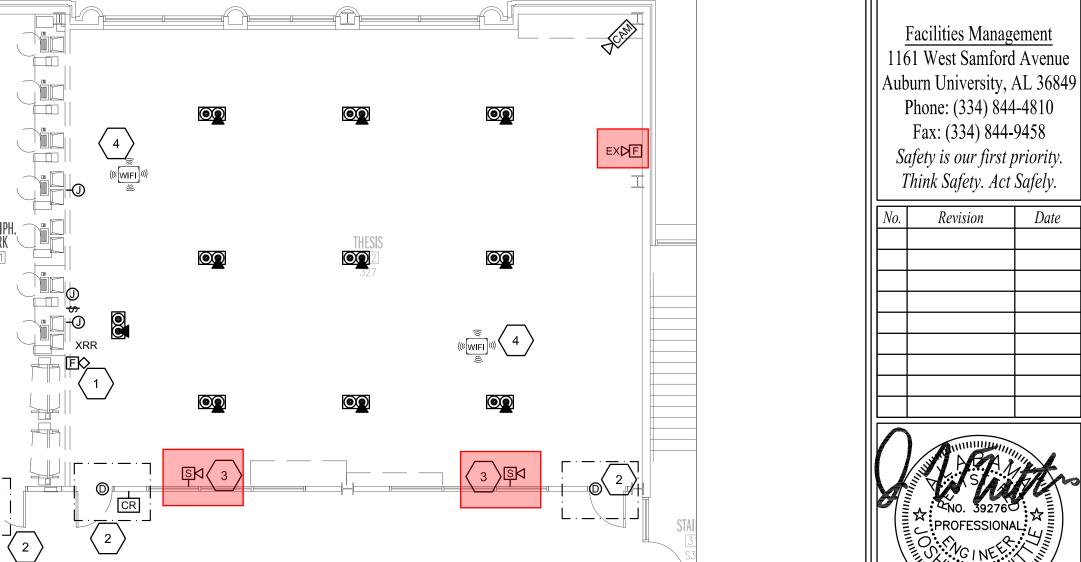



SUED FOR:

 \sim enter 25 & 3-103

SHEET TITLE: PARTIAL THIRD **FLOOR PLAN -ELECTRICAL DEMOLITION** DRAWN BY:

CHECKED BY:

12/20/2024 PROJECT NUMBER AU: 23-103 PROJECT NUMBER DCM: 2240699

PROJECT NUMBER CMH: SHEET NUMBER:



From: Shane Johnson

Sent: Monday, April 21, 2025 3:41 PM

To: Kelly O'Neal-Young

Subject: RE: 23-103 - Miller Gorrie - Fire Alarm Outage.pdf

I approve

Shane Johnson

Supervisor Zone 3

Auburn University Facilities Management C: 334-734-1601 Ljohnsha@auburn.edu

From: Kelly O'Neal-Young <onealke@auburn.edu>

Sent: Monday, April 21, 2025 3:38 PM

To: Kenneth Sullins <sullike@auburn.edu>; Shane Johnson <johnsha@auburn.edu>; Ben Farrow <farrocb@auburn.edu>; Mellissa Watson <mmw0020@auburn.edu>; Julie Huff <hilljul@auburn.edu>; Kristi Rendleman <klr0069@auburn.edu>; Eric Moore <jem0028@auburn.edu>; Bruce Arnold <gba0004@auburn.edu>; Bob Hix <hixjame@auburn.edu>; Nolan Yon <yonbenj@auburn.edu>; Jessica Covington <jlc0105@auburn.edu>

Cc: Mark Bourgeois <mab0010@auburn.edu>

Subject: 23-103 - Miller Gorrie - Fire Alarm Outage.pdf

All,

Please see attached Fire Alarm Outage for Gorrie Center RM's 327 and 325. We are beginning construction and demolition work starting Monday, 4/28 and will need the Fire Alarm devices deactivated. The sprinkler system will still be active during the downtime of the system.

Let me know by replying to this email

Thank You,

Kelly O'Neal-Young

From: Bob Hix

Sent: Monday, April 21, 2025 3:44 PM

To: Kelly O'Neal-Young; Kenneth Sullins; Shane Johnson; Ben Farrow; Mellissa Watson; Julie

Huff; Kristi Rendleman; Eric Moore; Bruce Arnold; Nolan Yon; Jessica Covington

Cc: Mark Bourgeois

Subject: RE: 23-103 - Miller Gorrie - Fire Alarm Outage.pdf

Approved

Bob Hix, P.E.

C: 334-740-8247 | bobhix@auburn.edu

From: Kelly O'Neal-Young <onealke@auburn.edu>

Sent: Monday, April 21, 2025 3:38 PM

To: Kenneth Sullins <sullike@auburn.edu>; Shane Johnson <johnsha@auburn.edu>; Ben Farrow <farrocb@auburn.edu>; Mellissa Watson <mmw0020@auburn.edu>; Julie Huff <hilljul@auburn.edu>; Kristi Rendleman <klr0069@auburn.edu>; Eric Moore <jem0028@auburn.edu>; Bruce Arnold <gba0004@auburn.edu>; Bob Hix <hixjame@auburn.edu>; Nolan Yon <yonbenj@auburn.edu>; Jessica Covington <jlc0105@auburn.edu>

Cc: Mark Bourgeois <mab0010@auburn.edu>

Subject: 23-103 - Miller Gorrie - Fire Alarm Outage.pdf

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Let me know by replying to this email

Thank You,

Kelly O'Neal-Young

From: Ben Farrow

Sent: Monday, April 21, 2025 4:27 PM

To: Kelly O'Neal-Young

Cc: Richard Burt; Brandon Clarke

Subject: FW: 23-103 - Miller Gorrie - Fire Alarm Outage.pdf **Attachments:** 23-103 - Miller Gorrie - Fire Alarm Outage.pdf

Approved.

C. Ben Farrow, Ph.D.

Associate Dean for Academic Affairs and International Programs Professor, McWhorter School of Building Science College of Architecture, Design & Construction Auburn University
202 Dudley Commons | Auburn, AL 36849
334.844.4285 (office)

farrocb@auburn.edu | www.cadc.auburn.edu

From: Kelly O'Neal-Young <onealke@auburn.edu>

Date: Monday, April 21, 2025 at 3:37 PM

To: Kenneth Sullins <sullike@auburn.edu>, Shane Johnson <johnsha@auburn.edu>, Ben Farrow <farrocb@auburn.edu>, Mellissa Watson <mmw0020@auburn.edu>, Julie Huff <hilljul@auburn.edu>, Kristi Rendleman <klr0069@auburn.edu>, Eric Moore <jem0028@auburn.edu>, Bruce Arnold <gba0004@auburn.edu>, Bob Hix <hixjame@auburn.edu>, Nolan Yon <yonbenj@auburn.edu>, Jessica Covington <jlc0105@auburn.edu>

Cc: Mark Bourgeois <mab0010@auburn.edu>

Subject: 23-103 - Miller Gorrie - Fire Alarm Outage.pdf

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Let me know by replying to this email

Thank You,

Kelly O'Neal-Young

From: Jessica Covington

Sent: Monday, April 21, 2025 4:54 PM

To: Kelly O'Neal-Young; Kenneth Sullins; Shane Johnson; Ben Farrow; Mellissa Watson; Julie

Huff; Kristi Rendleman; Eric Moore; Bruce Arnold; Bob Hix; Nolan Yon

Cc: Mark Bourgeois

Subject: RE: 23-103 - Miller Gorrie - Fire Alarm Outage.pdf

Hi Kelly, I approve.

Thank you,



Jessica L. Covington, CSP Safety and Health Program Manager

Risk Management and Safety 1161 W. Samford Ave., Bldg. 9 | Auburn, AL 36849 (C) 334-734-1715

From: Kelly O'Neal-Young <onealke@auburn.edu>

Sent: Monday, April 21, 2025 3:38 PM

To: Kenneth Sullins <sullike@auburn.edu>; Shane Johnson <johnsha@auburn.edu>; Ben Farrow <farrocb@auburn.edu>; Mellissa Watson <mmw0020@auburn.edu>; Julie Huff <hilljul@auburn.edu>; Kristi Rendleman <klr0069@auburn.edu>; Eric Moore <jem0028@auburn.edu>; Bruce Arnold <gba0004@auburn.edu>; Bob Hix <hixjame@auburn.edu>; Nolan Yon <yonbenj@auburn.edu>; Jessica Covington <jlc0105@auburn.edu>

Cc: Mark Bourgeois <mab0010@auburn.edu>

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Let me know by replying to this email

Thank You,

Kelly O'Neal-Young

Project Manager - Construction Management **Auburn University Facilities Management**

From: Julie Huff

Sent: Monday, April 21, 2025 5:04 PM

To: Kelly O'Neal-Young

Cc: Kenneth Sullins; Shane Johnson; Ben Farrow; Mellissa Watson; Kristi Rendleman; Eric

Moore; Bruce Arnold; Bob Hix; Nolan Yon; Jessica Covington; Mark Bourgeois

Subject: Re: 23-103 - Miller Gorrie - Fire Alarm Outage.pdf

Provost office approves.

On Apr 21, 2025, at 3:37 PM, Kelly O'Neal-Young <onealke@auburn.edu> wrote:

All,

Please see attached Fire Alarm Outage for Gorrie Center RM's 327 and 325. We are beginning construction and demolition work starting Monday, 4/28 and will need the Fire Alarm devices deactivated. The sprinkler system will still be active during the downtime of the system.

Let me know by replying to this email

Thank You,

Kelly O'Neal-Young

Project Manager - Construction Management
Auburn University Facilities Management
1161 W Samford Ave, Auburn University, AL 36849
C: 770-318-8277 | onealke@auburn.edu

<23-103 - Miller Gorrie - Fire Alarm Outage.pdf>

From: Bruce Arnold

Sent: Monday, April 21, 2025 4:34 PM

To: Kelly O'Neal-Young; Kenneth Sullins; Shane Johnson; Ben Farrow; Mellissa Watson; Julie

Huff; Kristi Rendleman; Eric Moore; Bob Hix; Nolan Yon; Jessica Covington

Cc: Mark Bourgeois

Subject: RE: 23-103 - Miller Gorrie - Fire Alarm Outage.pdf

I approve

Bruce

Gary B. "Bruce" Arnold, CEFP

AU '83

Assistant Director, Maintenance

Facilities Management

Auburn University

Cell: 334-734-3225

Email: gba0004@auburn.edu 1161 West Samford Avenue Auburn, AL 36849

OUR CORE VALUES.



From: Kelly O'Neal-Young <onealke@auburn.edu>

Sent: Monday, April 21, 2025 3:38 PM

To: Kenneth Sullins <sullike@auburn.edu>; Shane Johnson <johnsha@auburn.edu>; Ben Farrow <farrocb@auburn.edu>; Mellissa Watson <mmw0020@auburn.edu>; Julie Huff <hilljul@auburn.edu>; Kristi Rendleman <klr0069@auburn.edu>; Eric Moore <jem0028@auburn.edu>; Bruce Arnold <gba0004@auburn.edu>; Bob Hix <hixjame@auburn.edu>; Nolan Yon <yonbenj@auburn.edu>; Jessica Covington <jlc0105@auburn.edu>

Cc: Mark Bourgeois <mab0010@auburn.edu>

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Let me know by replying to this email

Thank You,

From: Kenneth Sullins

Sent: Tuesday, April 22, 2025 9:13 AM

To: Kelly O'Neal-Young; Shane Johnson; Ben Farrow; Mellissa Watson; Julie Huff; Kristi

Rendleman; Eric Moore; Bruce Arnold; Bob Hix; Nolan Yon; Jessica Covington

Cc: Mark Bourgeois

Subject: RE: 23-103 - Miller Gorrie - Fire Alarm Outage.pdf

I approve

From: Kelly O'Neal-Young <onealke@auburn.edu>

Sent: Monday, April 21, 2025 3:38 PM

To: Kenneth Sullins <sullike@auburn.edu>; Shane Johnson <johnsha@auburn.edu>; Ben Farrow <farrocb@auburn.edu>; Mellissa Watson <mmw0020@auburn.edu>; Julie Huff <hilljul@auburn.edu>; Kristi Rendleman <klr0069@auburn.edu>; Eric Moore <jem0028@auburn.edu>; Bruce Arnold <gba0004@auburn.edu>; Bob Hix <hixjame@auburn.edu>; Nolan Yon <yonbenj@auburn.edu>; Jessica Covington <jlc0105@auburn.edu>

Cc: Mark Bourgeois <mab0010@auburn.edu>

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Thank You,

Kelly O'Neal-Young